


| Rev | Date       | By | Check | Issue       |
|-----|------------|----|-------|-------------|
| 00  | 23.11.2020 | SM | AC    | Final Issue |
| 01  |            |    |       |             |

**Notes**

- This drawing should be read in conjunction with all relevant architectural and engineering drawings.
- Contractor to confirm the location and level of any existing services etc., uncovered during the works.
- Contractor to confirm the location and level of any existing sewers prior to the commencement of any works. Any confirmation of any existing services shall be the engineer's responsibility.
- Contractor to confirm the location of all existing services, buried and overhead, prior to the commencement of the works.
- All setting out shall be in accordance with the drawings and shall not be used for setting out purposes.
- All works to comply with current British Standards and Regulations. The Contractor shall verify all dimensions on site and report any discrepancies immediately to the Engineer.
- All attenuation storage volumes noted are detailed design.
- Surface water drainage system to be developed further during detailed design.

**Legend**

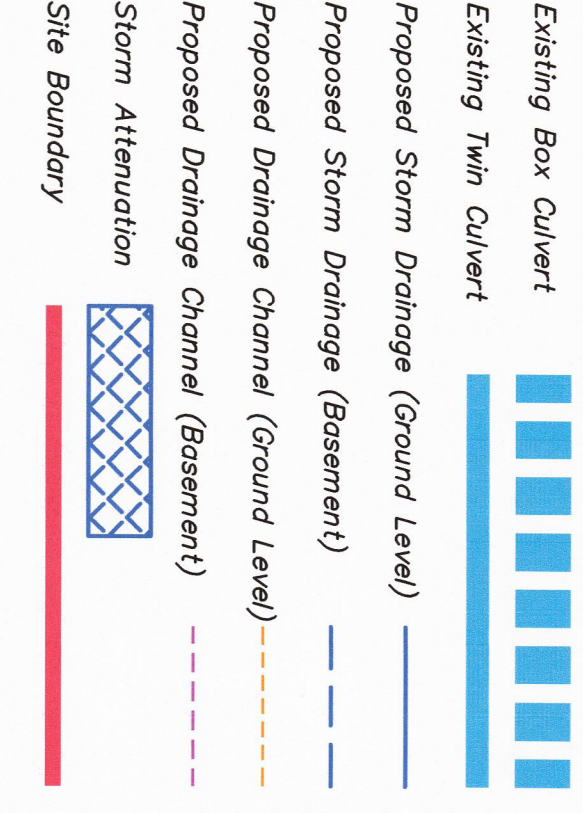



**PRELIMINARY DRAWING**

Queens Parade Development

Drawing Title: Drainage Plan (Ground Level)  
 Surface Water Run-Off Discharge to DfI Rivers Culvert

Client: Bodge Marine Limited  
 Date: Nov 2020  
 Scale: 1:500

Project Number: 1920442  
 Drawing Number: DC XX XX GA C 107 00

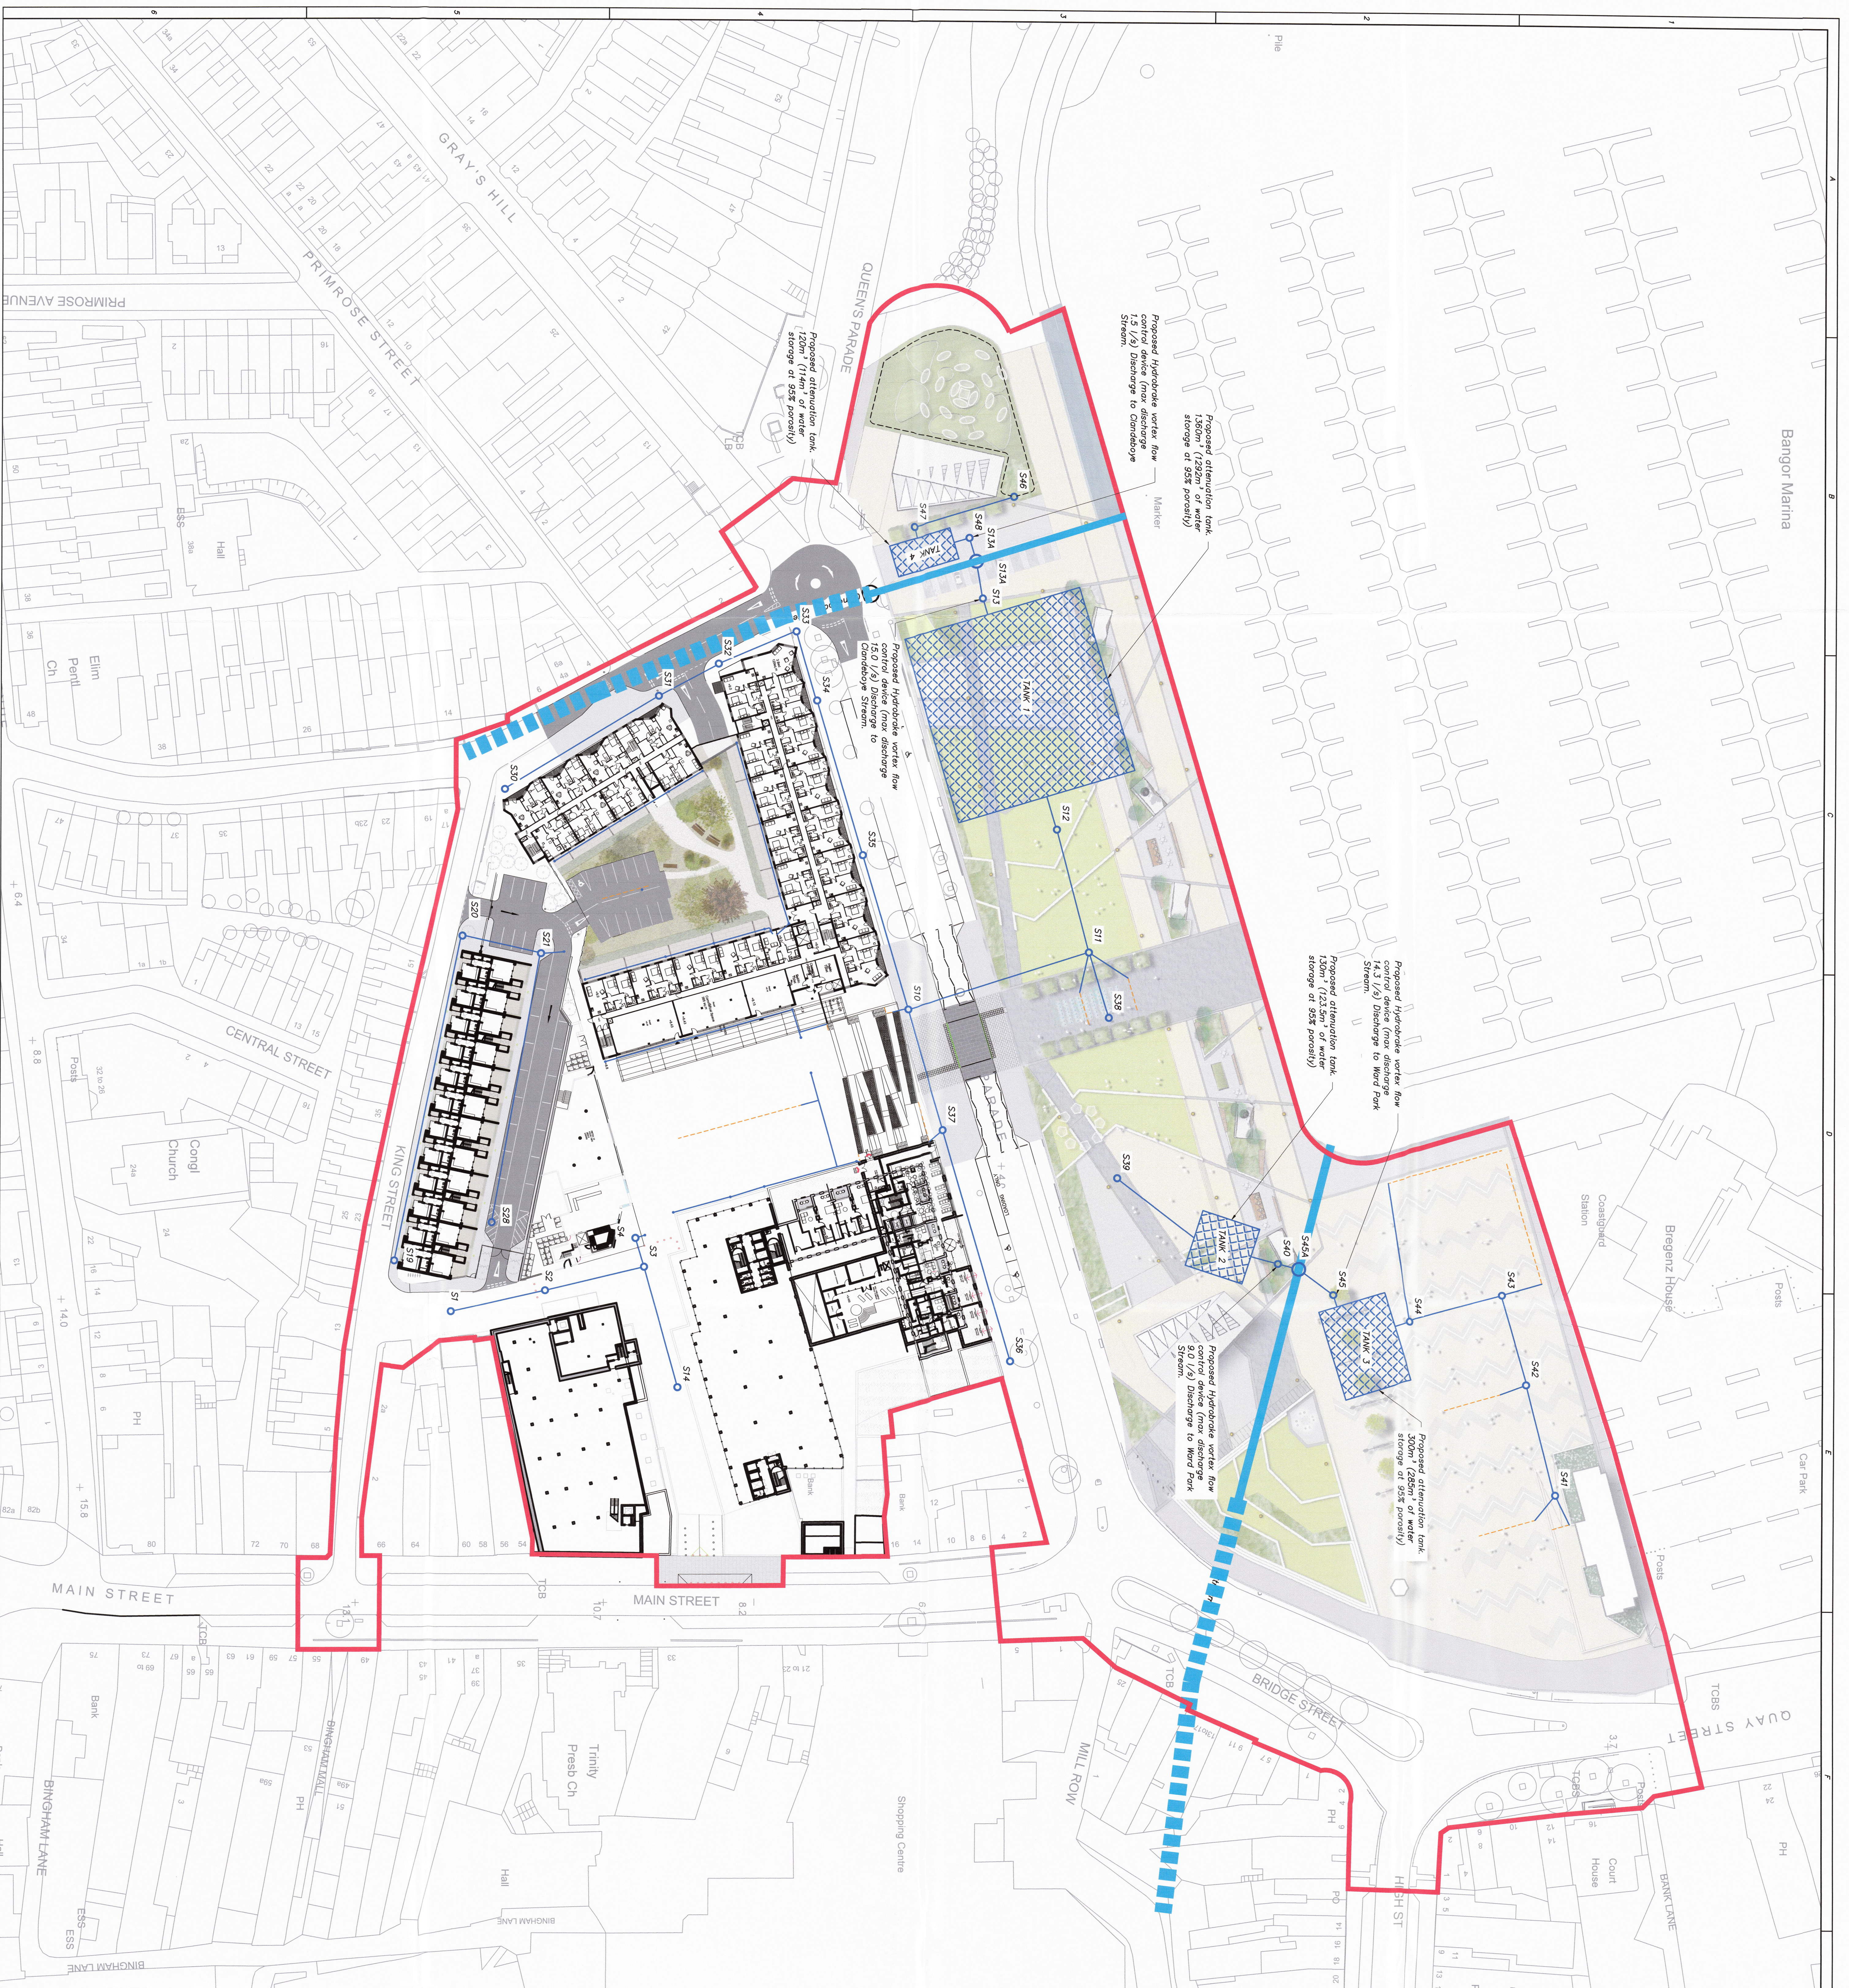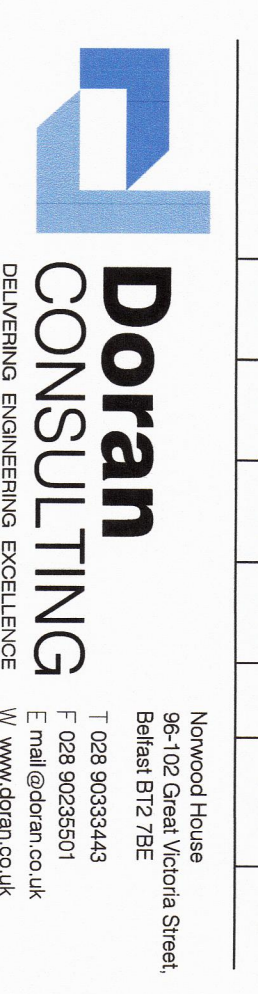

Planning Act (NI) 2011  
 Drawing Number: 804  
 Approved: 29 SEP 2022  
 Decision Ref No: LA06/2020/0097

7.5 NOV 2020

LA06/2020/0097